

### Blacktown City Council

## Assessment report to **Sydney Central City Planning Panel**

Panel reference: 2017SWC068

#### **Development application**

**DA** number

SPP-17-00007

**Date of lodgement** 

27 March 2017

**Applicant** 

The Wickwood Property Group Pty Ltd

Owner

R, M, E and M Haddad

**Proposed** development Construction of 2 residential flat buildings (8 storeys) comprising 170 apartments, 236 car parking spaces in 2 basement levels and associated civil and

landscaping works

Street address

Proposed Lot 1 in subdivision of Lot 74 DP208203

59 Cudgegong Road, Rouse Hill

Notification period

23 July to 6 August 2018

Number of submissions

1 (in support)

#### **Assessment**

#### Panel criteria

Section 7, SEPP (State and Regional Development) 2011

Capital investment value (CIV) over \$30 million (DA has CIV of \$44,633,296 incl GST)

#### **Relevant section** 4.15(1)(a) matters

- State Environmental Planning Policy (State and Regional Development) 2011
- State Environmental Planning Policy (Sydney Region Growth Centres) 2006
- State Environmental Planning Policy (Infrastructure) 2007
- State Environmental Planning Policy No. 65 (Design Quality of Residential Apartment Development) and Apartment Design Guide
- State Environmental Planning Policy No. 55 Remediation of Land
- State Environmental Planning Policy (Building Sustainability Index: BASIX) 2004
- Sydney Regional Environmental Plan No. 20 Hawkesbury-Nepean River
- Draft Amendment to SEPP (Sydney Region Growth Centres) 2006
- Blacktown City Council Growth Centre Precincts Development Control Plan 2010

#### Report prepared by Bertha Gunawan

Report date

18 March 2019

Recommendation

Approve, subject to the conditions listed in attachment 7.

#### **Attachments**

- Location map
- 2 Aerial image
- Zoning extract
- Detailed information about proposal and DA submission material
- Development application plans 5
- Assessment against planning controls
- Draft conditions of consent



Summary of section 4.15 matters	
Have all recommendations in relation to relevant section 4.15 matters been summarised Yes in the Executive summary of the Assessment report?	j
Legislative clauses requiring consent authority satisfaction	
Have relevant clauses in all applicable environmental planning instruments, where the consent authority must be satisfied about a particular matter, been listed and relevant recommendations summarised in the Executive summary of the Assessment report?	i
Clause 4.6 Exceptions to development standards	
If a written request for a contravention to a development standard (clause 4.6 of the LEP) has been received, has it been attached to the Assessment report?	applicable
Special Infrastructure Contributions	
Does the DA require Special Infrastructure Contributions conditions (section 7.24)?	
Conditions	
Have draft conditions been provided to the applicant for comment?	



### Contents

1	Executive summary	. 4
2	Location	
3	Site description	.4
4	Background	.5
5	The proposal	.6
6	Assessment against planning controls	.6
7	Key issues	.6
8	Issues raised by the public	.7
9	External referrals	
10	Internal referrals	.8
11	Conclusion	.8
12	Recommendation	.8



#### 1 Executive summary

- 1.1 The key issues that need to be considered by the Panel in respect of this application are:
  - the lack of deep soil area where large trees can be planted, as required by the Apartment Design Guide
  - non-compliance with building separation as required by the Apartment Design Guide.
- 1.2 Assessment of the application against the relevant planning framework and consideration of matters by our technical departments have not identified any issues of concern that cannot be dealt with by conditions of consent.
- 1.3 The application is assessed as satisfactory when evaluated against section 4.15 of the Environmental Planning and Assessment Act 1979.
- 1.4 This report recommends that the Panel approve the application subject to the recommended conditions listed in attachment 7 based on the grounds specified in the recommendation in Section 12 below.

#### 2 Location

- 2.1 The site is located within the Area 20 Precinct of the North West Growth Area.
- 2.2 The vision for the Area 20 Precinct is:

"To create a series of new walkable residential neighbourhoods supported by local retail, employment, community, open space and recreational opportunities ... the Precinct will provide for a range of densities, dwelling types and affordability options including larger lots and standard detached houses, with apartments in close proximity to Rouse Hill Town Centre and its associated public transport opportunities."

- 2.3 The location of the site is shown at attachment 1 and is illustrated in the aerial photograph at attachment 2.
- 2.4 Immediately to the south is the proposed Tallawong Local Centre. Within 200 m is the under construction Tallawong Metro Station, providing access to many parts of Metropolitan Sydney via the railway network. Consequently, the site is within very close walking distance of future public transport, local shops, businesses, services and community facilities.
- 2.5 The site has frontage to Cudgegong Road, which provides excellent vehicular access via Schofields Road and Windsor Road to surrounding suburbs, employment areas and commercial centres such as Rouse Hill, Bella Vista and Castle Hill.
- 2.6 The site is located in a band of land zoned R3 Medium Density Residential that surrounds the proposed Tallawong Local Centre and metro railway station. An area of bushland reserve zoned E2 Environmental Conservation is 100 m to the north of the site and the open space/riparian arm of Second Ponds Creek is 500 m to the east. This corridor stretches north to Rouse Hill Regional Park and the Rouse Hill House estate heritage site.

#### 3 Site description

- 3.1 The subject land is on the western side of Cudgegong Road and is known as proposed Lot 1, 59 Cudgegong Road, Rouse Hill.
- 3.2 The site has a total area of 8,940 m<sup>2</sup> that includes the road reservation of 3,266 m<sup>2</sup> and the proposed development area of 5,674 m<sup>2</sup>.
- 3.3 The site is generally rectangular in shape, with a curved south-eastern corner due to the required construction of a roundabout at the intersection of Cudgegong Road and proposed Road No 2. The eastern and western frontages are about 110 m long, with the northern and southern frontages up to 218 m long.



- 3.4 The eastern section of the site fronting Cudgegong Road is affected by an easement for transmission lines, containing an existing transmission pylon with overhead wires running in a north-west to south-east direction.
- 3.5 The site is in an elevated position with gently sloping topography, characterised by a fall of 4 m across the site from west to east, and 2 m across the site from south to north. The highest point of the site is at the south-western corner, with a fall of 6 m to the north-eastern corner.
- 3.6 Existing on the site is a dwelling and a number of outbuildings. Approval to demolish the existing buildings was part of the 2017 subdivision DA.
- 3.7 There are several existing trees on site and all are to be removed. Many of these have been approved for removal for the construction of roadworks in the existing subdivision consent. The site is not identified under the planning regime as containing critical habitat or endangered species.
- 3.8 Under State Environmental Planning Policy (Sydney Region Growth Centres) 2006 (SEPP 2006) the site is zoned R3 Medium Density Residential, with development standards of:
  - 26 m maximum height of buildings
  - 1.75:1 maximum floor space ratio
  - 1,000 m<sup>2</sup> minimum lot size for a residential flat building
  - 45 dwellings per hectare minimum residential density.
- 3.9 An extract of the zoning plan for the site and surrounds is at attachment 3.
- 3.10 The site is not identified in the SEPP as being of European or Aboriginal heritage significance or as being flood affected.

#### 4 Background

- 4.1 The original DA was received on 27 March 2017. Elements of the proposal were redesigned twice in response to our concerns with numerous inadequacies of the proposal. These included excessive building height, failure to satisfy FSR and site coverage, inadequate building boundary setbacks and internal separation, insufficient deep soil and landscape tree planting, unsatisfactory access to communal open space areas and the facilities within, poor internal amenity of some apartments (solar access, apartment depth and width), excessive car parking and basement area, apartment mix (insufficient number of 3 bedroom apartments and Universal Design apartments), lack of outdoor clothes drying area and excessively high boundary fences.
- 4.2 Concerns were also raised about the lack of adequate consultation with Endeavour Energy about the communal open space and bio retention basin area proposed to be located in the electricity transmission easement area on the Cudgegong Road frontage of the site. The final revised plans now being considered were submitted in June 2018.
- 4.3 Related development consent No 16-04138 was issued in 2017 to demolish the existing dwelling and associated structures on the subject Lot 74 DP 208203, and to subdivide the land into 2 lots, being proposed Lot 1 and Lot 2, with associated earthworks, infrastructure and road construction. The purpose of the subdivision consent is to prepare the site for residential flat building development. Proposed Lot 1 retains full frontage to Cudgegong Road and proposed Lot 2 is sited to the west of proposed Lot 1, separated by proposed Road No. 3 as shown on the plans at attachment 5.
- 4.4 The subject proposal is for the construction of 2 residential apartment buildings on proposed Lot 1. A separate DA for 4 residential flat buildings has been submitted for proposed Lot 2 and will be the subject of a separate assessment report to the Panel.



#### 5 The proposal

- 5.1 The DA was lodged by The Wickwood Group Pty Ltd.
- 5.2 The Applicant proposes the construction of 2 x 8 storey residential flat buildings, comprising 170 apartments over a single basement of 2 levels that provides parking for 236 cars, and associated works including civil engineering, stormwater and site landscaping.
- 5.3 Other details about the proposal are at attachment 4, and a copy of the development plans is at attachment 5.

#### 6 Assessment against planning controls

- 6.1 A full assessment of the Development Application against relevant planning controls is provided at attachment 6, including:
  - Environmental Planning and Assessment Act 1979
  - State Environmental Planning Policy (State and Regional Development) 2011
  - State Environmental Planning Policy (Infrastructure) 2007
  - State Environmental Planning Policy No. 55 Remediation of Land
  - State Environmental Planning Policy (Building Sustainability Index: BASIX) 2004
  - State Environmental Planning Policy (Sydney Region Growth Centres) 2006
  - Sydney Regional Environmental Plan No. 20 Hawkesbury-Nepean River
  - Central City District Plan
  - Blacktown City Council Growth Centre Precincts Development Control Plan 2018.

#### 7 Key issues

## 7.1 The lack of deep soil area where large trees can be planted as required by the Apartment Design Guide

- 7.1.1 The total deep soil area of 840 m<sup>2</sup> meets the minimum 15% and 6 m dimension requirements of the Apartment Design Guide (ADG). However, the deep soil area is largely within the electricity transmission easement on the Cudgegong Road frontage of the site, meaning that large trees cannot be planted here due to the need for maintenance access to the easement at all times.
- 7.1.2 The location of the easement on the eastern site boundary has had an impact on the design solution for the site. No buildings or major works and only limited planting can be located in this area. The easement area is therefore proposed to be used for communal open space and a bio-retention area.
- 7.1.3 As required by SEPP (Infrastructure) 2007, Endeavour Energy was consulted in relation to the proposal and had no objections to the proposal subject to conditions.
- 7.1.4 Due to the limitations of this easement for deep soil area for tree growth, the Applicant was requested to provide an additional area of deep soil in the centre of the site. The Applicant has provided an area of 40 m² and has also identified that additional narrow strips of 2 m width on the boundary of the site can also be used for large tree planting, as the adjacent public footpath areas will provide for some tree root growth.



7.1.5 Given the particular circumstances of this site, the proposal is considered satisfactory for deep soil areas and the capacity to sustain tree growth on the site, although more internal deep soil areas would be desirable within the communal open space areas of the site.

#### 7.2 Non-compliance with building separation required by the Apartment Design Guide

- 7.2.1 As discussed in 7.1 above, the location of the electricity transmission easement has had an impact on the design solution for the site. As a result, the buildings are located closer to one another than desirable, as the Applicant seeks to maximise the amount of permissible floor space in the portion of the site available for building construction.
- 7.2.2 The Applicant proposes the use of blank walls or screens on balconies where building separation on the site is less than the required 12 m for the first 4 levels and 18 metres for those above that.
- 7.2.3 This is not an urban form outcome that is usually consistent with the objectives of the control for building separation, which seeks to increase separation in proportion to the building height to achieve a desirable building form. The lack of adequate separation can create narrow, overshadowed open space areas between buildings.
- 7.2.4 The proposed building separation between the southern third of Buildings A and B is 9.5 m (compared to required 12 m), with one blank wall and balconies with privacy screens. At the southern end of Building A on all levels above level 1, distances between balconies with louvre screens are 3.4 m and 7.4 m. Without some additional ameliorative measures, this can provide poor visual amenity and acoustic privacy for residents of these apartments, and limits light and solar access.
- 7.2.5 Where building separation is inadequate and will reduce the amenity for residents, screens are proposed to improve visual privacy. A condition is proposed to implement the recommendations of the consultant Acoustic Report submitted with the application, including that balconies are to be suitably treated to ensure acoustic privacy for residents from nearby units.
- 7.2.6 For the 5<sup>th</sup>, 6<sup>th</sup> and 7<sup>th</sup> floors, separation distances are the same as for the levels below (being 9.5 m), but because there are no openings that allow for overlooking the intent behind the normal 9 m building separation is considered to be met. The mostly blank walls provide poor presentation to the street and communal open space areas, however we propose to condition for an improved visual treatment. Also, the proposed trees to be planted around the perimeter of the site will improve amenity.

### 8 Issues raised by the public

- 8.1 The proposed development was notified to property owners and occupiers in the locality between 23 July and 6 August 2018. The application was also advertised in local newspapers and a sign was erected on the site.
- 8.2 We received 1 submission in support of the application. It indicated a positive integration with the proposed development at 34 42 Tallawong Road, Rouse Hill.

#### 9 External referrals

9.1 The DA was referred to the following external authorities for comment:



Authority	Comments
Endeavour Energy	Acceptable subject to conditions
NSW Police	Acceptable subject to conditions
Rural Fire Service	Acceptable subject to conditions
Roads and Maritime Services	Acceptable subject to conditions

#### 10 Internal referrals

10.1 The DA was referred to the following internal sections of Council for comment:

Section	Comments	
Heritage	Acceptable subject to conditions	
Engineering	Acceptable subject to conditions	
Waste	Acceptable subject to conditions	
Environmental Health	Acceptable subject to conditions	
Building	Acceptable subject to conditions	
Traffic	Acceptable subject to conditions	
City Architect	Acceptable	
Open Space	Acceptable subject to conditions	
Property	Acceptable	
Natural Areas	Acceptable subject to conditions	

#### 11 Conclusion

11.1 The proposed development has been assessed against all relevant matters and, on balance given the circumstances of the easement though the site, is considered to be satisfactory. It is considered that the likely impacts of the development have been satisfactorily addressed and that the proposal is in the public interest. The site is considered suitable for the proposed development subject to conditions.

#### 12 Recommendation

- Approve Development Application SPP-17-00007 subject to the conditions listed in attachment 7.
- 2 Council officers notify the Applicant and submitter of the Panel's decision.



Bertha Gunawan

Assistant Team Leader - Projects

Judith Portelli Manager Development Assessment

Glennys James

Director Planning and Development






#### Subject Site 181/208203 130/1138775 83/208203 100/1049793 114/208203 101/1049793 11/633090 2/540894 3/135883 81/208203 92/1223103 1/540894 61/30186 1/1214741 210/208203 126/208200 62/30186 124(20620) 211/208203 63/30186 77/208203 135/208203 34/30186 17/1202113 34/39341 33/30186 65/30186 134/208203 75/208203 33/39341 132/208203 32/608689 66/30186 32/39341 133/208203 31/608689 119/208203 31/39341 120/208203 72/208203 68/30186 8/1190434 30/39341 7/1190434 6/1190434 71/208203 10/27220 \5/119043/ 69/30186 11/27220 29/39341 70/30186 1/1175409 2/1175409 27/39341 10/1185116 26/3934 28/39341 26/30186 13/1168129 12/1168129 14/1189148 13/1189148 10/1185113




Aerial image (as at 14 January 2019)

Subject Site

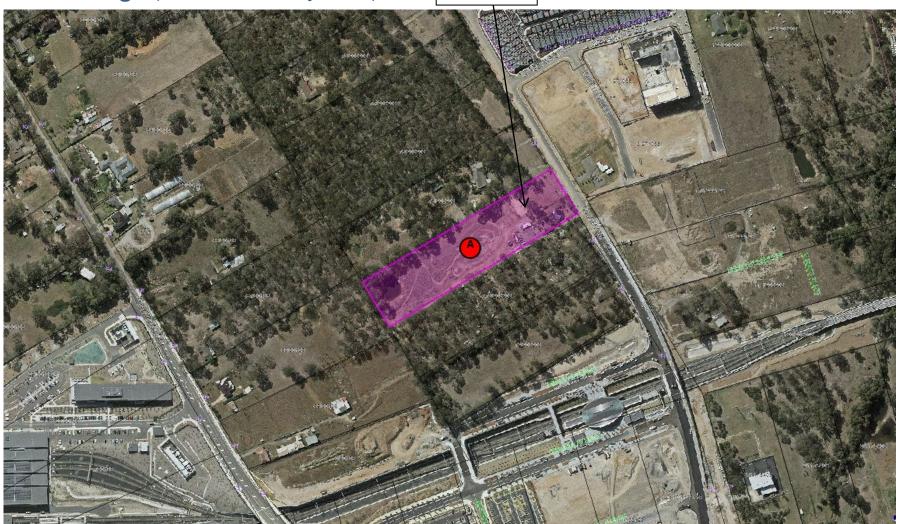



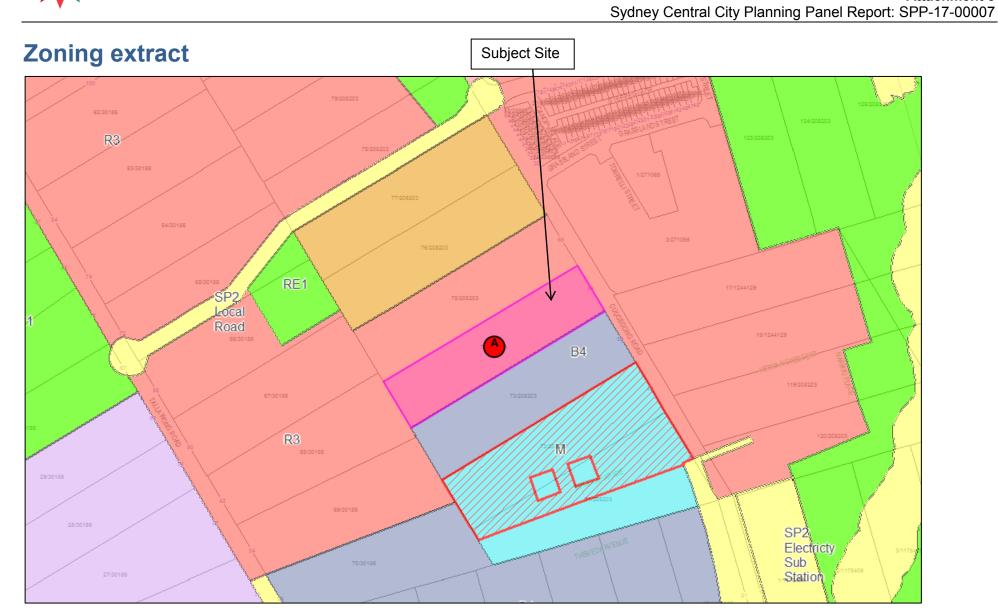



## Detailed information about proposal and DA submission material

#### 1 Overview

- 1.1 The Development Application (DA) seeks approval for:
  - removal of all existing trees on the site
  - construction of 2 x 8 storey residential flat buildings, comprising 170 apartments over a single basement of 2 levels that provides parking for 236 cars and 57 bicycles, storage and waste services areas and a loading bay
  - associated works, including civil engineering, stormwater and site landscaping.

#### 2 Composition of the 2 residential flat buildings

- 2.1 Building A is a U-shaped 8 storey building containing 108 apartments adjacent to the electricity easement on Cudgegong Road. The driveway and a communal open space area separate the 2 arms of the building. Pedestrian access is via the adjacent communal open space areas or directly from the southern street Road No. 2 into the lobby of the eastern arm of the building. A 10 m wide opening in the building at ground level and level 1 on the southern frontage (to the communal open space area) contains apartments above on levels 2 to 7.
- 2.2 Building B is also an 8 storey building containing 62 apartments and runs north to south. It is parallel to the 2 long arms of building A, from which it is separated by the most western communal open space area. Pedestrian access is via this communal open space area at gate 1 on northern Road No. 1 and gate 2 on southern Road No. 2.
- 2.3 Vehicle access into the single basement, which caters for both buildings, is from proposed Road No. 1 on the northern frontage.
- 2.4 The relevant development standards are satisfied. The highest point of the buildings is 26 m and the floor space ratio is 1.66:1 (or 1.75:1 including internal corridors). The residential density is approximately 200 dwellings per hectare.
- 2.5 The dwelling mix is:
  - 35 x 1 bedroom apartments (20.6%)
  - 111 x 2 bedroom apartments (65.3%)
  - 24 x 3 bedroom apartments (14.1%).

This mix is acceptable, though more 3 bedroom apartments would be desirable in a complex of 170 dwellings.

2.6 There are 34 (20%) liveable apartments, incorporating universal design requirements identified on the plans, including 17 (10%) adaptable units, with 17 resident disabled parking spaces.

#### 3 External elements

3.1 Landscaped communal open space areas are provided on the ground level between buildings A and B, between the arms of building A and in the transmission easement area on the Cudgegong Road eastern site boundary.

- 3.2 These areas are readily accessible to residents. Facilities shown on plans include BBQs, a picnic area, benches, a children's play area, paved and turfed areas. A ground level common room is provided, accessible from the communal open space area at the base of building A.
- 3.3 Letterboxes are provided at the eastern direct entrance into building A from Road No. 2 and at gates 1 and 2 entrances to the most western communal open space area that lies between buildings A and B.
- 3.4 A variety of building elements, materials and colours are proposed using grey tones with lighter highlight elements. The proposed external finishes and materials include brick, paint rendered concrete, glass, aluminium and powder coated metal.
- 3.5 Balconies on the street front, use of different light and dark coloured elements and materials, and solid and open features, provide some building articulation and modulation.

#### 4 Consultant reports

- 4.1 The DA is accompanied by consultant reports relating to traffic and parking assessment, contamination, salinity and geotechnical assessment, acoustic impact, trees, bushfire, universal access, engineering and stormwater management.
- 4.2 A BASIX Certificate for the proposal states that it meets the NSW Government requirements for sustainability. The SEPP 65 Design Verification Statement was prepared by Josefino Noy Santiago, Registered Architect, Registration Number 5968, of Pens Design Studio.

## NatHERS Thermal Performance Specifications (BASIX Thermal Comfort) Site 1, 59 Cudgegong Road, Rouse Hill

These are the Specifications upon which the NatHERS Assessment is based. If details included in these Specifications vary from other drawings or written specifications, these Specifications shall take precedence. If only one specification option is detailed for a building element, that specification must apply to all instances of that element for the project.

Windows	Glass	Frame	U value	SHGC	Detail
Default	Single glazed, clear	Aluminium	6.70	0.57	Generally for window types: Awning, bi-fold, casement, tilt 'n' turn
Default	Single glazed, clear	Aluminium	6.70	0.70	Generally for window types: Sliding window/ door, double hung, fixed, louvre
Default	Single glazed, low E High solar gain	Aluminium	5.40	0.58	See NatHERS glazing schedule for application
Default	Single glazed, low E Low solar gain	Aluminium	5.60	0.41	See NatHERS glazing schedule for application
Default	Double glazed, clear	Aluminium	4.80	0.59	See NatHERS glazing schedule for application
Default	Double glazed, low E High solar gain	Aluminium	4.30	0.53	See NatHERS glazing schedule for application

Skylights	Glass	Frame	U value	SHGC	Detail	
External walls	Construction	Added Inst	ulation	Detail		
Brick Veneer		R2.0		To floor levels: G, 1 and 6, 7		
Concrete (AFS)	)	R1.5		To floor levels: 2, 3, 4, 5		
Concrete (AFS)	)	R2.5		To unit: B02		

Internal walls Construction	Added Insulation	Detail
Plasterboard on studs	None	Within units
Concrete (AFS)	None	Party/ common walls
Concrete (AFS)	R1.0	To units: A59, A90 - internal walls adjoining stairwell

Floors	Construction	Added Insulation	Covering	Detail
Concrete		None	Carpet generally; tiles wet areas	Generally
Concrete		R1.5	Carpet generally; tiles wet areas	To units: A01, A02, A16, A59, A60, A61, A65, A90, A91, A92, B01, B02, B03, B32, B33, B34

Ceilings	Construction	Added Insulation	Detail
Plasterboard		None	Generally
Plasterboard		R1.5	To ceilings below roof to units: A01, A02, A03, A60, A61, A92, B02, B03
Plasterboard		R2.5	To all level 7 units

Roof	Construction	Added Insulation	Detail	
Concrete (refer to ceiling detail above)				
Metal deck (refer to ceiling detail above)				

#### Other Requirements

All exhaust fans and downlights (if installed) to be **sealed** to prevent air infiltration





#### **PERSPECTIVE**

DRAWING NI IMBER

DA-A209

DA-A210

DA-A300

DA-A301

DA-A302

DA-A303

DA-A304

DA-A305

DA-A400

ARCHITECTURAL DRAWINGS

LEVEL 7

ROOF PLAN

**ELEVATIONS** 

ELEVATIONS

SECTIONS

SECTIONS

SECTIONAL ELEVATIONS

TYPICAL FLOOR PLANS

26.0M BUILDING HEIGHT PLANE

DESCRIPTION

DITAVVING NOMBEI	DEGOTIII TIOIV	1104101011	DITAWING NOMBE	DEGOTHI HON	1104101011
DA-A000	COVER PAGE		DA-A500	PERSPECTIVES	
DA-A001	SITE SUMMARY	E	DA-A600	FSR CALCULATION DIAGRAMS	D
DA-A100	SITE ANALYSIS		DA-A601	SITE COVERAGE, LANDSCAPE DIAGRAMS	D
DA-A101	SITE PLAN/NOTIFICATION		DA-A602	COS Solar Access Diagrams	
DA-A200	BASEMENT PLAN LVL-1	E	DA-A603	SHADOW DIAGRAMS	С
DA-A201	BASEMENT PLAN LVL-2	С	DA-A604	SHADOW DIAGRAMS	С
DA-A202	GROUND FLOOR PLAN	E	DA-A605	SOLAR & CROSS VENTILATION DIAGRAMS	D
DA-A203	LEVEL 1	E	DA-A605.1	SOLAR & CROSS VENTILATION DIAGRAMS	D
DA-A204	LEVEL 2	E	DA-A605.2	3D VIEW TO SUN	
DA-A205	LEVEL 3	E	DA-A605.3	3D VIEW TO SUN	
DA-A206	LEVEL 4	E	DA-A605.4	3D VIEW TO SUN	
DA-A207	LEVEL 5	E	DA-A605.5	SOLAR STUDY	
DA-A208	LEVEL 6	F	DA-A605 6	SOLAR STUDY	

DA-A605.8

DA-A605.9

DA-A605.10

DA-A605.11

DA-A700

DA-A800

DA-A900

PROPOSED RESIDENTIAL DEVELOPMENT

ARCHITECTURAL DRAWINGS

SOLAR STUDY

SOLAR STUDY

SOLAR STUDY SOLAR STUDY

FACADE DETAILS

UNIT SCHEDULES

STAGING PLANS

DESCRIPTION

DRAWING NI IMBED

59 CUDGEGONG ROAD ROUSE HILL, NSW 2155







#### **EXECUTIVE SUMMARY**

	REQUIRED	PROPOSED
01. SITE AREA	-	DEVELOPABLE SITE AREA 8490.00m²
02. ZONE	R3	MEDIUM DENSITY
03. BUILDING HEIGHT	MAX. 26m	26m
04. FSR	1.75:1	1.65:1
FSA	14,857.50m <sup>2</sup>	14,013.00
05. SITE COVERAGE	MAX. 4245.00m <sup>2</sup> (50% OF SITE)	4241.00m <sup>2</sup> 49.95% OF SITE
06. LANDSCAPE AREA MAXIMUM	2547.00m <sup>2</sup> 30% OF SITE	3039.90m <sup>2</sup> 35.81% OF SITE
07. DEEP SOIL ZONE	1273.50m <sup>2</sup> 15% OF SITE	1854.52m <sup>2</sup> 21.84% OF SITE
08.COMMUNAL OPEN SPACE	2122.50m <sup>2</sup> 25% OF SITE	2595.70m <sup>2</sup> 30.57% OF SITE
09. NUMBER OF UNITS		170 UNITS
10. ADAPTABLE UNIT VISITABLE-(Universal Housing	10% 17.00 10%	35 1B 111 2B 24 3B 10% 17
Guidelines Silver Level) 20% 34 Units including Adaptable Units	17.00	34
11. CAR PARKING SPACES Car Parking Rates based on Council's DO	CP	
1 BEDROOM 1 / UNIT	35	35 SPACES
2 BEDROOM 1 / UNIT	111	111 SPACES
3 BEDROOM 1.5 / UNIT	36	36 SPACES
VISITOR 1 / 5 UNIT	34	34 SPACES
TOTAL	216	235 SPACES
ADAPTABLE	170(10%)	18 SPACES
BICYCLE 1 / 3 UNIT	56.66	57 SPACES
12. SOLAR ACCESS	70% 2 HRS	72.35% 123/170 UNITS
13. CROSS VENTILATION	60%	70.60% 120/170 UNITS

## **pens Design** Studio ABN 47 814 248 580 noy santlago architect: 5968

			$C\Delta D$	Plans
F	12-10-18	Refer to notes as requested by council		i iaiis
E	05-03-18	Refer to notes as requested by council	DESIGN	Solutions
D	15-12-17	Refer to notes as requested by council	39 Cumberland Rd Auburn NSV	V 2144
С	06-10-17	DRAFT ISSUE- for consultants review	P: (02) 8068 2177	ABN 88 606 740 381
A	20-01-17	DRAFT ISSUE- for consultants review	<ul> <li>M: 0416009172</li> <li>E: info@cadplans.net.</li> </ul>	0.1
ISSUE	DATE	AMENDMENT	E. IIIIO@Gaupians.net.	du

NOTES:

ALL DEMONDRES HIM MALINETINES AND SHOULD BE VERFIELD ON SITE OF BULDER PRIOR TO COMMERCIATE OF WORKER

TO COMMERCIATE OF WORKER

STRUCK HIM THE BUILDING CODE OF MATTRIAN, RELEVINT AUSTRALIAN

STRUCK HIM THE STRUCK HIM TO THE BUILDING CODE OF MATTRIAN, RELEVINT AUSTRALIAN

SALD DEMONDRES THAT THE STRUCK TO SERVING COMMERCE AND DEMONSTOR BUILDING TO

ALL DEMONDRES OF THE THE STRUCK HIM T





COPYRIGHT:
THIS DESIGN AND PRINT REMAINS THE PROPERTY OF CAD PLANS PLY LID AND MUST
NOT BE USED, REPRODUCED OR COPIED WITHOUT PERMISSION FROM CAD PLANS PLY LI

# PROJECT: RESIDENTIAL DEVELOPMENT SITE ADDRESS: 59 CUDGEGONG ROAD, ROUSE HILL,NSW 2155 CUENT: The Wickwood Property Group Pty Ltd

SITE SUMMARY

DESIGN: | DRAWN: | DATE: | SCALE:

F
SHEET:
DA-A001


DEVELOPMENT YIELD

SITE AREA				8,4	90.00m <sup>2</sup>
BUILDING	Α				
LEVELS	1 BED	2 BEDS	3 BEDS	Units/FLR	Area/FLR
7TH	4	8	2	14	1,122.26m <sup>2</sup>
6TH	4	8	2	14	1,122.26m <sup>2</sup>
5TH	4	8	2	14	1,122.26m <sup>2</sup>
4TH	4	8	2	14	1,122.26m <sup>2</sup>
3RD	4	8	2	14	1,122.26m <sup>2</sup>
2ND	4	8	2	14	1,122.26m <sup>2</sup>
1ST	3	8	2	13	1,054.00m <sup>2</sup>
GROUND	1	4	6	11	1,150.64m <sup>2</sup>
BASEMENT 1					
BASEMENT 2					
TOTAL	28	60	20	108	8,938.20m <sup>2</sup>
BUILDING	В				
LEVELS	1 BED	2 BEDS	3 BEDS	Units/FLR	Area/FLR
7TH	1	7	0	8	630.24m <sup>2</sup>
6TH	1	7	0	8	630.24m <sup>2</sup>
5TH	1	7	0	8	630.24m <sup>2</sup>
4TH	1	7	0	8	630.24m <sup>2</sup>
3RD	1	7	0	8	630.24m <sup>2</sup>
2ND	1	7	0	8	630.24m <sup>2</sup>
1ST	1	7	0	_	000 042
101			U	8	630.24m <sup>2</sup>
GROUND	0	2	4	8 6	630.24m <sup>2</sup>
	-				
GROUND	-				
GROUND BASEMENT 1	-				663.10m <sup>2</sup>
GROUND BASEMENT 1 BASEMENT 2	0	2	4	6	663.10m <sup>2</sup>
GROUND BASEMENT 1 BASEMENT 2	0	2	4	6	

20.59% 65.30% 14.11% 100%

TOTAL GROSS FLOOR AREA

14,013.00m<sup>2</sup>

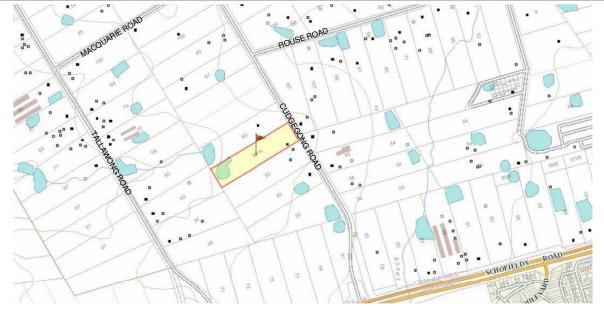


#### **LOCATION MAP**






VIEW TO SITE FROM CUDGEGONG ROAD-1

VIEW TO SITE FROM CUDGEGONG ROAD-2

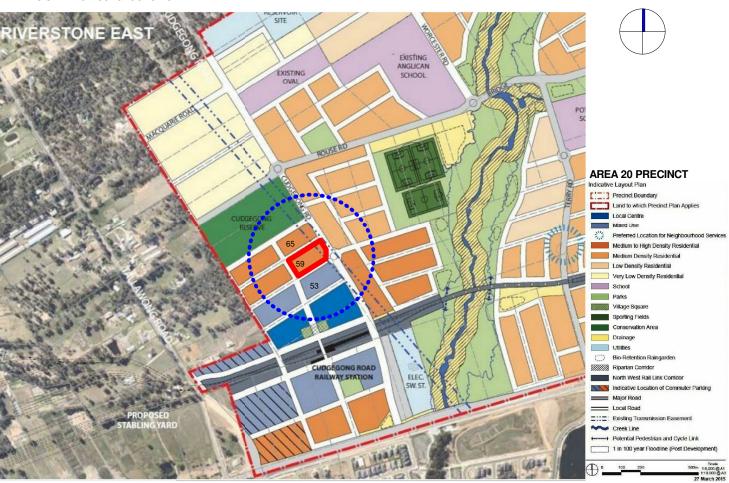

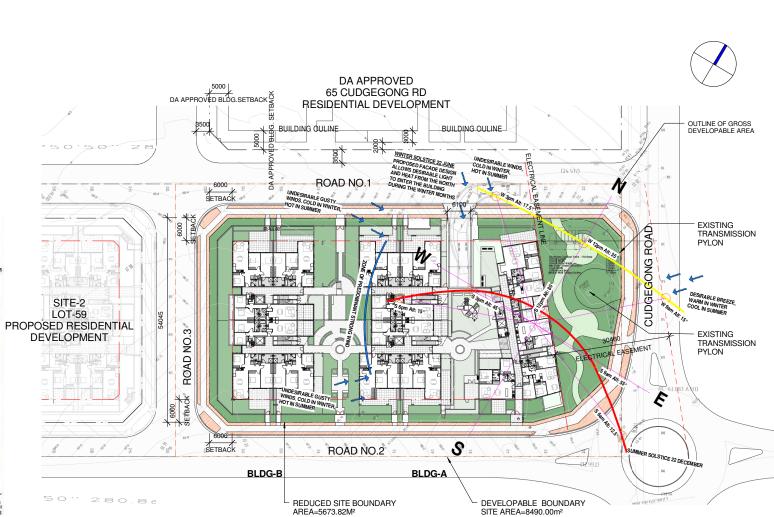

#### **AREA 20 PRECINCT PLAN**



			CAD	Plans
E	05-03-18	Refer to notes as requested by council	DESIGN	Solutions
D	15-12-17	Refer to notes as requested by council	39 Cumberland Rd Auburn NSV	V 2144
С	06-10-17	DRAFT ISSUE- for consultants review	P: (02) 8068 2177	ABN 88 606 740 381
Α	20-01-17	DRAFT ISSUE- for consultants review	M: 0416009172 E: info@cadplans.net.a	211
ISSUE	DATE	AMENDMENT	L. IIIO@caupians.net.a	au




## DEVELOPMENT APPLICATION

SITE ANALYSIS 1:500 @A1 1:1000@A3

RESIDENTIAL DEVELOPMENT 59 CUDGEGONG ROAD, ROUSE HILL, NSW 2155 The Wickwood Property Group Pty Ltd


SITE ANALYSIS DA-A100

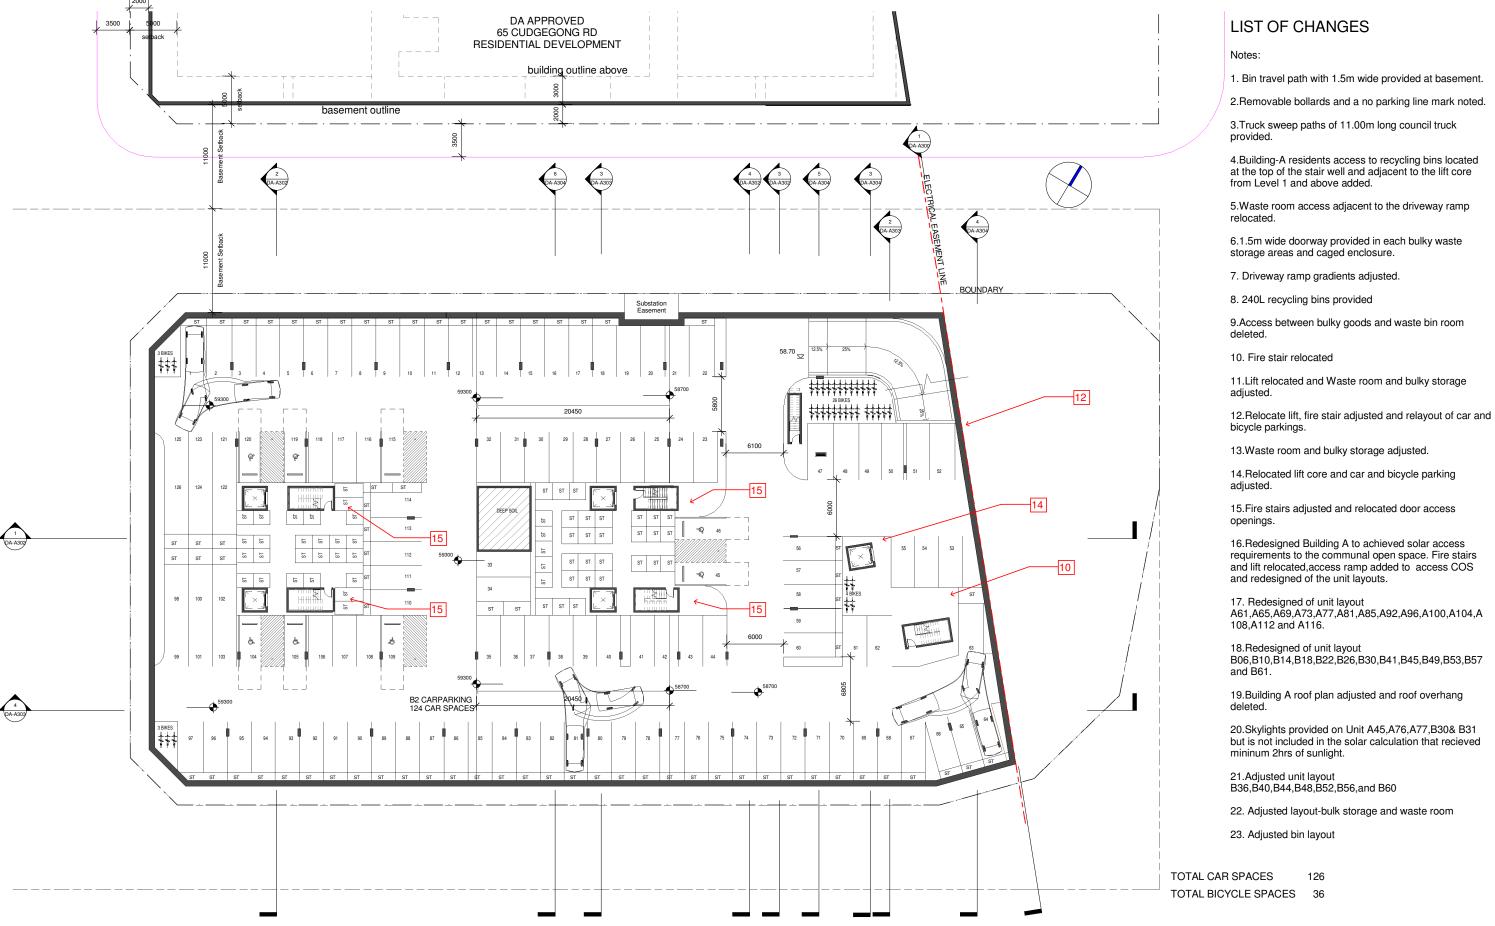

#### **BASEMENT PLAN LVL-2**

- 1:200 @ A1 sheet
- 1:400 @ A3 sheet



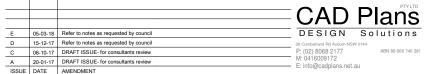






## DEVELOPMENT APPLICATION VOU DIG





DA-A201

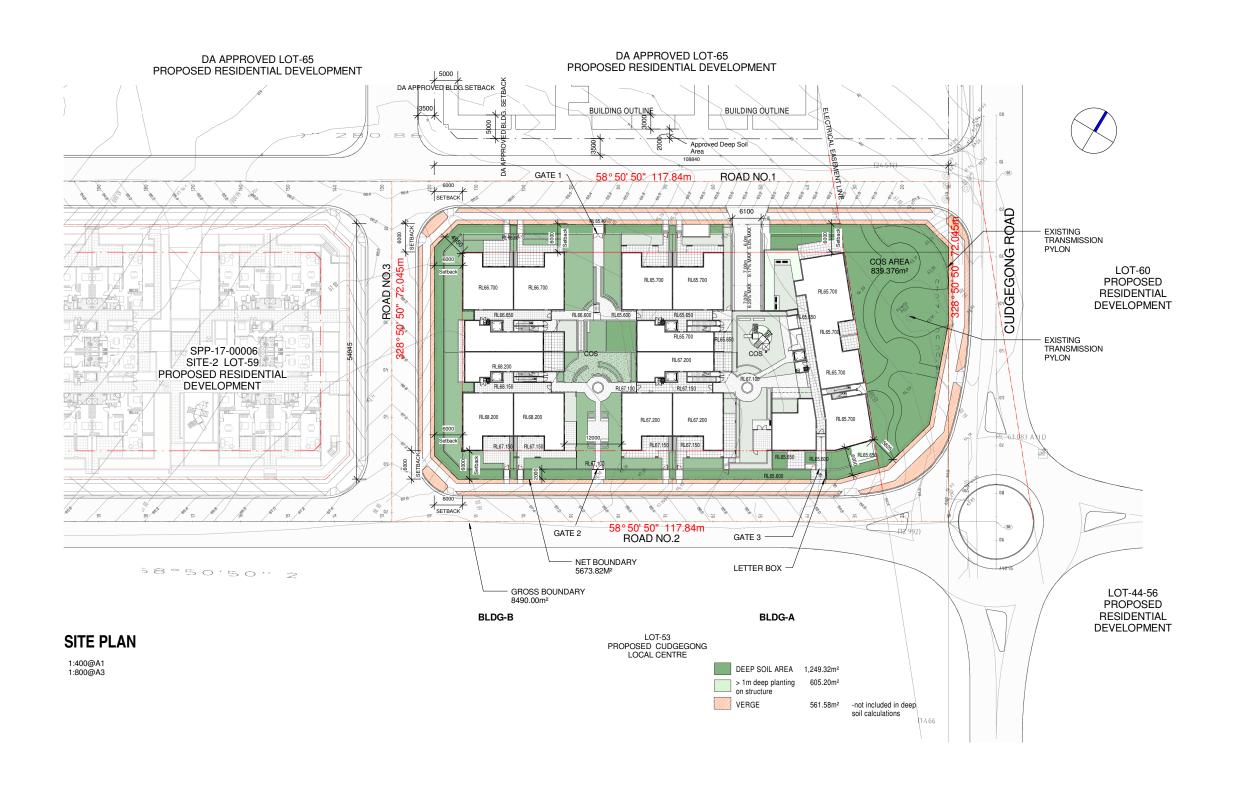



CAD Plans


DESIGN SOLUTIONS E 05-03-18 Refer to notes as requested by council
D 15-12-17 Refer to notes as requested by council C 06-10-17 DRAFT ISSUE- for consultants review
A 20-01-17 DRAFT ISSUE- for consultants review
ISSUE DATE AMENDMENT E: info@cadplans.net.au





PROJECT: RESIDENTIAL DEVELOPMENT	SHE
RESIDENTIAL DEVELOPIVIENT	SI
59 CUDGEGONG ROAD, ROUSE HILL,NSW	
2155	DES
CLIENT: The Wickwood Property Group Pty Ltd	NS

NOW	SHEET TITLE:	.AN/NOT	IFICATIC	N	ISSUE:
NSW	DESIGN: NS	DRAWN: AJRSA	DATE: JUNE 2016	SCALE: AS SHOWN	DA-A101

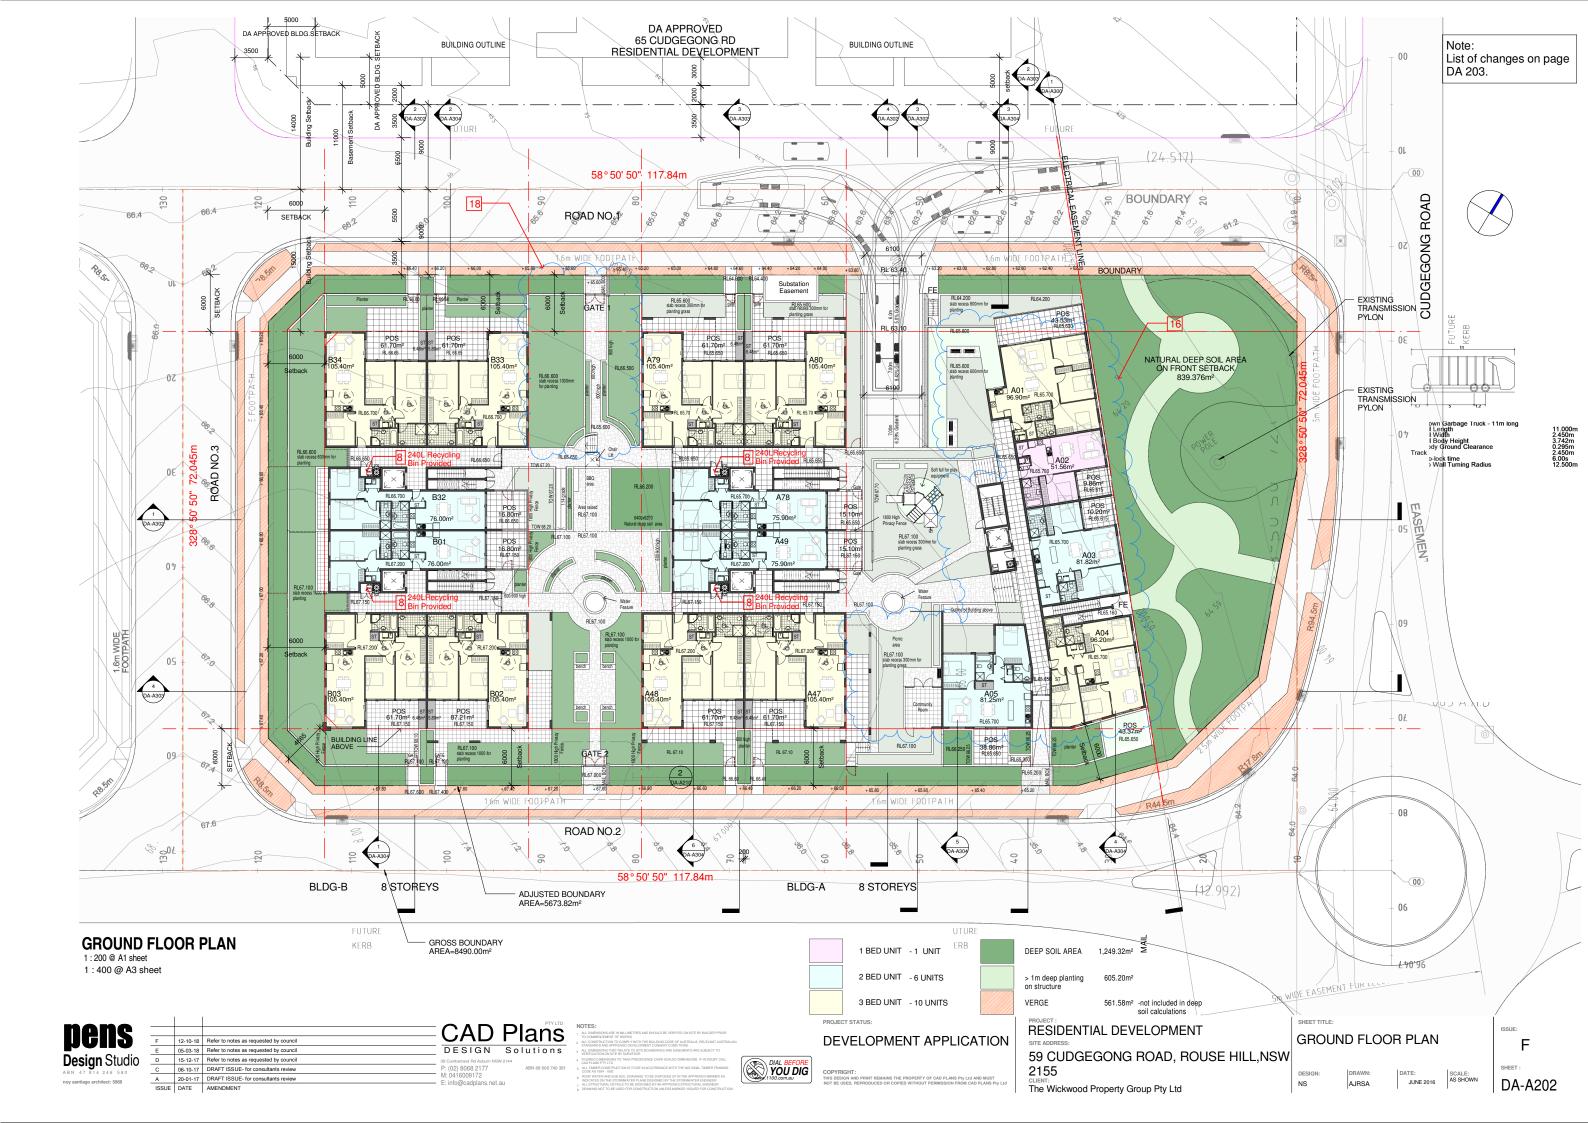

#### LIST OF CHANGES

Notes:

1. Bin travel path with 1.5m wide provided at basement.

2. Removable bollards and a no parking line mark noted.

3.Truck sweep paths of 11.00m long council truck provided.

4.Building-A residents access to recycling bins located at the top of the stair well and adjacent to the lift core from Level 1 and above added.

5. Waste room access adjacent to the driveway ramp relocated.

6.1.5m wide doorway provided in each bulky waste storage areas and caged enclosure.

7. Driveway ramp gradients adjusted.

8. 240L recycling bins provided

9.Access between bulky goods and waste bin room deleted

10. Fire stair relocated

11.Lift relocated and Waste room and bulky storage adjusted.

12. Relocate lift, fire stair adjusted and relayout of car and bicycle parkings.

13. Waste room and bulky storage adjusted.

14.Relocated lift core and car and bicycle parking adjusted.

15. Fire stairs adjusted and relocated door access openings.

16.Redesigned Building A to achieved solar access requirements to the communal open space. Fire stairs and lift relocated, access ramp added to access COS and redesigned of the unit layouts.

17. Redesigned of unit layout A61,A65,A69,A73,A77,A81,A85,A92,A96,A100,A104,A 108,A112 and A116.

18.Redesigned of unit layout B06,B10,B14,B18,B22,B26,B30,B41,B45,B49,B53,B57 and B61.

19.Building A roof plan adjusted and roof overhang deleted.

20. Skylights provided on Unit A45,A76,A77,B30& B31 but is not included in the solar calculation that recieved mininum 2hrs of sunlight.


21.Adjusted unit layout B36,B40,B44,B48,B52,B56,and B60

22. Adjusted layout-bulk storage and waste room

23. Adjusted bin layout





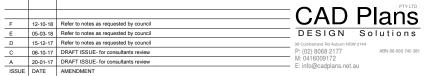





PROJECT:	SHEET TITLE:
RESIDENTIAL DEVELOPMENT	LEVEL
SITE ADDRESS:	
59 CUDGEGONG ROAD, ROUSE HILL, NSW	
2155	DESIGN:
CLIENT: The Wickwood Property Group Pty Ltd	NS



#### LIST OF CHANGES Notes: 1. Bin travel path with 1.5m wide provided at basement. 2. Removable bollards and a no parking line mark noted. 58° 50' 50". 117.84m 3. Truck sweep paths of 11.00m long council truck provided. 4. Building-A residents access to recycling bins located at the top of the stair well and adjacent to the lift core from Level 1 and above added. 5. Waste room access adjacent to the driveway ramp relocated. 6.1.5m wide doorway provided in each bulky waste storage areas and caged enclosure. 7. Driveway ramp gradients adjusted. 8. 240L recycling bins provided 9. Access between bulky goods and waste bin room deleted. 10. Fire stair relocated 11.Lift relocated and Waste room and bulky storage 12. Relocate lift, fire stair adjusted and relayout of car and bicycle parkings. 13. Waste room and bulky storage adjusted. 1 DA-A30 14.Relocated lift core and car and bicycle parking SETBACK adjusted. 15. Fire stairs adjusted and relocated door access 240L Recycling Bin Provided 8 16.Redesigned Building A to achieved solar access requirements to the communal open space. Fire stairs BALC 12.00m<sup>2</sup> RL73.115 and lift relocated, access ramp added to access COS and redesigned of the unit layouts. 6000 17. Redesigned of unit layout A61,A65,A69,A73,A77,A81,A85,A92,A96,A100,A104,A A15 108,A112 and A116. 18.Redesigned of unit layout B06,B10,B14,B18,B22,B26,B30,B41,B45,B49,B53,B57 19. Building A roof plan adjusted and roof overhang 20. Skylights provided on Unit A45, A76, A77, B30& B31 but is not included in the solar calculation that recieved BLDG-B 8 STOREYS 8 STOREYS BLDG-A

deleted.

mininum 2hrs of sunlight.

21.Adjusted unit layout B36,B40,B44,B48,B52,B56,and B60

22. Adjusted layout-bulk storage and waste room

23. Adjusted bin layout





			$C\Delta D$	Plans
F	12-10-18	Refer to notes as requested by council		i lallo
E	05-03-18	Refer to notes as requested by council	DESIGN	Solutions
D	15-12-17	Refer to notes as requested by council	39 Cumberland Rd Auburn NSV	W 2144
С	06-10-17	DRAFT ISSUE- for consultants review	P: (02) 8068 2177	ABN 88 606 740 381
Α	20-01-17	DRAFT ISSUE- for consultants review	M: 0416009172 E: info@cadplans.net.	211
ICCLIE	DATE	AMENDAENT	L. IIIIO@caupiaiis.iiei.	au





PROJECT:	SHEET TITLE:		
RESIDENTIAL DEVELOPMENT SITE ADDRESS:	LEVEL 2		
59 CUDGEGONG ROAD, ROUSE HILL,NSW			
2155	DESIGN:	DRAWN:	
The Wickwood Property Group Pty Ltd	NS	AJRSA	

DA-A204

#### LIST OF CHANGES Notes: 1. Bin travel path with 1.5m wide provided at basement. 2 DA-A303 2. Removable bollards and a no parking line mark noted. 58°50'50" 117.84m 3. Truck sweep paths of 11.00m long council truck provided. 15000 21600 12000 25560 22150 4. Building-A residents access to recycling bins located at the top of the stair well and adjacent to the lift core from Level 1 and above added. 5. Waste room access adjacent to the driveway ramp relocated. 6.1.5m wide doorway provided in each bulky waste storage areas and caged enclosure. 7. Driveway ramp gradients adjusted. BALC 11.50m RL75.615 BALC 11.50m<sup>2</sup> RL74.615 8. 240L recycling bins provided 14785 9. Access between bulky goods and waste bin room deleted. RL74.700 10. Fire stair relocated 11.Lift relocated and Waste room and bulky storage 240L Recycling Bin Provided 8 12. Relocate lift, fire stair adjusted and relayout of car and bicycle parkings. 13. Waste room and bulky storage adjusted. 14.Relocated lift core and car and bicycle parking adjusted. 15. Fire stairs adjusted and relocated door access 16.Redesigned Building A to achieved solar access requirements to the communal open space. Fire stairs BALC 10.20m<sup>2</sup> RL76.115 and lift relocated, access ramp added to access COS and redesigned of the unit layouts. 9500 17. Redesigned of unit layout A61,A65,A69,A73,A77,A81,A85,A92,A96,A100,A104,A A21 RL74.700 108,A112 and A116. 6000 18.Redesigned of unit layout B06,B10,B14,B18,B22,B26,B30,B41,B45,B49,B53,B57 19. Building A roof plan adjusted and roof overhang 20. Skylights provided on Unit A45, A76, A77, B30& B31 18 but is not included in the solar calculation that recieved BLDG-B 8 STOREYS STOREYS BLDG-A

deleted.

mininum 2hrs of sunlight.

21.Adjusted unit layout B36,B40,B44,B48,B52,B56,and B60

22. Adjusted layout-bulk storage and waste room

23. Adjusted bin layout



1:400 @ A3 sheet

pens
<b>Design</b> Studio
ABN 47 814 246 580
nov santiago architect: 5968

			O 4 D	PTYLTD	P
			$(\Delta I)$	Plans	1
F	12-10-18	Refer to notes as requested by council		i iaiis	2
E	05-03-18	Refer to notes as requested by council	DESIGN	Solutions	3
D	15-12-17	Refer to notes as requested by council	39 Cumberland Rd Auburn NSV	W 2144	4
С	06-10-17	DRAFT ISSUE- for consultants review	P: (02) 8068 2177	ABN 88 606 740 381	5
A	20-01-17	DRAFT ISSUE- for consultants review	M: 0416009172 E: info@cadplans.net.	0.1	6
IOOUE	0.475	AMENDA SELECT	E. IIIIO@caupiaris.riet.	du	7





58° 50' 50" 117.84m

PROJECT: RESIDENTIAL DEVELOPMENT SITE ADDRESS:	SHEET TITLE:  LEVEL 3			
59 CUDGEGONG ROAD, ROUSE HILL,NSW				
2155 CLIENT: The Wickwood Property Group Pty Ltd	DESIGN: NS	DRAWN: AJRSA	DATE: JUNE 2016	SCALE: AS SHOWN

DA-A205

1 BED UNIT - 5 UNITS

3 BED UNIT - 2 UNITS

- 15 UNITS

2 BED UNIT





			$C\Delta D$	Plans
F	12-10-18	Refer to notes as requested by council		i iaiis
E	05-03-18	Refer to notes as requested by council	DESIGN	Solutions
D	15-12-17	Refer to notes as requested by council	39 Cumberland Rd Auburn NSV	V 2144
С	06-10-17	DRAFT ISSUE- for consultants review	P: (02) 8068 2177	ABN 88 606 740 381
Α	20-01-17	DRAFT ISSUE- for consultants review	M: 0416009172 E: info@cadplans.net.	211
ISSUE	DATE	AMENDMENT	L. IIIIo@caupiaiis.iiet.	au





PROJECT:	SHE
RESIDENTIAL DEVELOPMENT	
SITE ADDRESS:	ᆫ
59 CUDGEGONG ROAD, ROUSE HILL,NSW	
2155	DES
CLIENT:	NS
The Wickwood Property Group Pty Ltd	





pens
<b>Design</b> Studio
ABN 47 814 246 580
noy santiago architect: 5968

			$C\Delta D$	Plans
F	12-10-18	Refer to notes as requested by council		i iaiis
E	05-03-18	Refer to notes as requested by council	DESIGN	Solutions
D	15-12-17	Refer to notes as requested by council	39 Cumberland Rd Auburn NSV	V 2144
С	06-10-17	DRAFT ISSUE- for consultants review	P: (02) 8068 2177	ABN 88 606 740 381
Α	20-01-17	DRAFT ISSUE- for consultants review	M: 0416009172 E: info@cadplans.net.a	211
ICCLIE	DATE	AMENDMENT	L. IIIIo@caupiaris.riet.i	au





PROJECT:	SHEET
RESIDENTIAL DEVELOPMENT	۱F۱
SITE ADDRESS:	
59 CUDGEGONG ROAD, ROUSE HILL, NSW	
2155 CLIENT:	DESIG
The Wickwood Property Group Pty I td	NS

SHEET TITLE:				ISSUE:
LEVEL	. 5			F
				SHEET:
DESIGN: NS	AJRSA	DATE: JUNE 2016	SCALE: AS SHOWN	DA-A207

#### LIST OF CHANGES Notes: 1. Bin travel path with 1.5m wide provided at basement. 2. Removable bollards and a no parking line mark noted. 2 DA-A303 58° 50' 50". 117.84m 3. Truck sweep paths of 11.00m long council truck provided. 22150 15000 21600 12000 25560 4. Building-A residents access to recycling bins located at the top of the stair well and adjacent to the lift core from Level 1 and above added. 5. Waste room access adjacent to the driveway ramp relocated. 6.1.5m wide doorway provided in each bulky waste storage areas and caged enclosure. BALC 11.50m² RL83.615 7. Driveway ramp gradients adjusted. BALC 11.50m<sup>2</sup> RL83.615 6000 8. 240L recycling bins provided 14785 9. Access between bulky goods and waste bin room A104 7.98m² deleted. 10. Fire stair relocated 11.Lift relocated and Waste room and bulky storage 240L Recycling 8-12. Relocate lift, fire stair adjusted and relayout of car and bicycle parkings. 13. Waste room and bulky storage adjusted. 14.Relocated lift core and car and bicycle parking adjusted. 15. Fire stairs adjusted and relocated door access 16.Redesigned Building A to achieved solar access requirements to the communal open space. Fire stairs and lift relocated, access ramp added to access COS RL85.115 BALC ST WANTED B25 and redesigned of the unit layouts. 6000 17. Redesigned of unit layout A61,A65,A69,A73,A77,A81,A85,A92,A96,A100,A104,A RL85,200 108,A112 and A116. A 18.Redesigned of unit layout B06,B10,B14,B18,B22,B26,B30,B41,B45,B49,B53,B57 19. Building A roof plan adjusted and roof overhang deleted. 20. Skylights provided on Unit A45, A76, A77, B30& B31 but is not included in the solar calculation that recieved mininum 2hrs of sunlight. BLDG-B 8 STOREYS STOREYS BLDG-A 21.Adjusted unit layout B36,B40,B44,B48,B52,B56,and B60

58°50'50" 117.84m

23. Adjusted bin layout

22. Adjusted layout-bulk storage and waste room

**LEVEL-6**1:200 @ A1 sheet

1:400 @ A3 sheet

none			
pens	F	12-10-18	Refer to notes as requested by council
_	E	05-03-18	Refer to notes as requested by council
<b>Design</b> Studio	D	15-12-17	Refer to notes as requested by council
ABN 47 814 246 580	С	06-10-17	DRAFT ISSUE- for consultants review

A 20-01-17 DRAFT ISSUE- for consultants review
ISSUE DATE AMENDMENT

CAD Plans
DESIGN Solutions
St Comborland Rd Aubum NSW 2144
P: (02) 8008 217
M: 0416009172
ABN 88 606 740 381







1 BED UNIT - 5 UNITS

2 BED UNIT - 15 UNITS

3 BED UNIT - 2 UNITS



## LIST OF CHANGES Notes:

- 1. Bin travel path with 1.5m wide provided at basement.
- 2. Removable bollards and a no parking line mark noted.
- 3. Truck sweep paths of 11.00m long council-truckprovided.
- 4. Building-A residents access to recycling bins located at the top of the stair well and adjacent to the lift core from Level 1 and above added.
- 5. Waste room access adjacent to the driveway ramp relocated.
- 6.1.5m wide doorway provided in each bulky waste storage areas and caged enclosure.
- 7. Driveway ramp gradients adjusted.
- 8. 240L recycling bins provided
- 9. Access between bulky goods and waste bin room deleted.
- 10. Fire stair relocated
- 11.Lift relocated and Waste room and bulky storage
- 12. Relocate lift, fire stair adjusted and relayout of car and bicycle parkings.
- 13. Waste room and bulky storage adjusted.
- 14.Relocated lift core and car and bicycle parking adjusted.
- 15. Fire stairs adjusted and relocated door access
- 16.Redesigned Building A to achieved solar access requirements to the communal open space. Fire stairs and lift relocated, access ramp added to access COS and redesigned of the unit layouts.
- 17. Redesigned of unit layout A61,A65,A69,A73,A77,A81,A85,A92,A96,A100,A104,A 108,A112 and A116.
- 18.Redesigned of unit layout B06,B10,B14,B18,B22,B26,B30,B41,B45,B49,B53,B57
- 19. Building A roof plan adjusted and roof overhang deleted.
- 20. Skylights provided on Unit A45, A76, A77, B30& B31 but is not included in the solar calculation that recieved mininum 2hrs of sunlight.
- 21.Adjusted unit layout B36,B40,B44,B48,B52,B56,and B60
- 22. Adjusted layout-bulk storage and waste room
- 23. Adjusted bin layout





			CVD	Plans	1
F	12-10-18	Refer to notes as requested by council	CAD	rians	2
E	05-03-18	Refer to notes as requested by council	DESIGN	Solutions	3
D	15-12-17	Refer to notes as requested by council	39 Cumberland Rd Auburn NSI	W 2144	4
С	06-10-17	DRAFT ISSUE- for consultants review	P: (02) 8068 2177	ABN 88 606 740 381	-
Α	20-01-17	DRAFT ISSUE- for consultants review	M: 0416009172 E: info@cadplans.net.	211	6
ISSUE	DATE	AMENDMENT	L. IIIIO@cdupidiis.iiet.	au	7






PROJECT:	SHEET
RESIDENTIAL DEVELOPMENT	l F
59 CUDGEGONG ROAD, RO	USE HILL NSW
2155	DESIG
CLIENT: The Wickwood Property Group Pty Ltd	NS

T TITLE: VEL 7 DA-A209



#### **ROOF PLAN.**

1:200 @ A1 sheet 1:400 @ A3 sheet

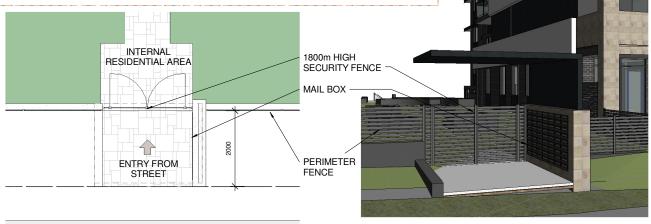

TYPICAL MAIL BOX & ENTRY PLAN
SCALE 1:50 @ A1
1:100 @ A3

**TYPICAL MAIL BOX & ENTRY STRUCTURE** 

**Pens**Design Studio

			~	PTY LTD
			CAD	Planc
			$O \cap D$	ııans
E	05-03-18	Refer to notes as requested by council	DESIGN	Solutions
D	15-12-17	Refer to notes as requested by council	39 Cumberland Rd Auburn NSW	2144
С	06-10-17	DRAFT ISSUE- for consultants review	P: (02) 8068 2177	ABN 88 606 740 381
Α	20-01-17	DRAFT ISSUE- for consultants review	M: 0416009172 E: info@cadplans.net.ai	
			E. IIIIO@Gaupians.net.ai	J

N	IOTES:
1	ALL DIMENSIONS ARE IN MILLIMETRES AND SHOULD BE VERIFIED ON SITE BY BUILDER PRIOR TO COMMENCEMENT OF WORKS
2	ALL CONSTRUCTION TO COMPLY WITH THE BUILDING CODE OF AUSTRALIA, RELEVANT AUSTRALI STANDARDS AND APPROVED DEVELOPMENT CONSENT CONDITIONS.
3	ALL DIMENSIONS THAT RELATE TO SITE BOUNDARIES AND EASEMENTS ARE SUBJECT TO VERIFICATION ON SITE BY SURVEYOR
4	FIGURED DIMENSIONS TO TAKE PRECEDENCE OVER SCALED DIMENSIONS. IF IN DOUBT CALL CAD PLANS PTY LTD
5	ALL TIMBER CONSTRUCTION IS TO BE IN ACCORDANCE WITH THE NATIONAL TIMBER FRAMING CODE AS 1684 - 1992
6	ROOF WATER AND SUB-SOIL DRAINAGE TO BE DISPOSED OF IN THE APPROVED MANNER AS INDICATED ON THE STORMWATER PLANS DESIGNED BY THE STORMWATER ENGINEER

N	IOTES:	
1	ALL DIMENSIONS ARE IN MILLIMETRES AND SHOULD BE VERIFIED ON SITE BY BUILDER PRIOR TO COMMENCEMENT OF WORKS	
2	ALL CONSTRUCTION TO COMPLY WITH THE BUILDING CODE OF AUSTRALIA, RELEVANT AUSTRALIAN STANDARDS AND APPROVED DEVELOPMENT CONSENT CONDITIONS.	
3	ALL DIMENSIONS THAT RELATE TO SITE BOUNDARIES AND EASEMENTS ARE SUBJECT TO VERIFICATION ON SITE BY SURVEYOR	
4	FIGURED DIMENSIONS TO TAKE PRECEDENCE OVER SCALED DIMENSIONS. IF IN DOUBT CALL CAD PLANS PTY LTD	
5	ALL TIMBER CONSTRUCTION IS TO BE IN ACCORDANCE WITH THE NATIONAL TIMBER FRAMING CODE AS 1684 - 1992	1(6
6	ROOF WATER AND SUB SOIL DRAINAGE TO BE DISPOSED OF IN THE APPROVED MANNER AS INDICATED ON THE STORMWATER PLANS DESIGNED BY THE STORMWATER ENGINEER	[/

	DEVELOPMENT APPLICATION
DIAL BEFORE YOU DIG	COPYRIGHT: THIS DESIGN AND PRINT REMAINS THE PROPERTY OF CAD PLANS PHY LII AND MUST NOT BE USED, REPRODUCED OR COPIED WITHOUT PERMISSION FROM CAD PLANS PHY LII

DECIDENTIAL DEVELODMENT	SH
RESIDENTIAL DEVELOPMENT	Ь
SITE ADDRESS:	H
59 CUDGEGONG ROAD, ROUSE HILL, NSW	
2155	DE
CLIENT:	NS
The Wickwood Property Group Pty Ltd	

	SHEET TITLE:					
	ROOF PLAN					
W						
	DESIGN: NS	DRAWN: AJRSA	DATE: JUNE 2016	SCALE: AS SHOWN		

DA-A210

#### **COLOUR AND FINISH**



**Design** Studio

DESIGN Solutions E 05-03-18 Refer to notes as requested by council
D 15-12-17 Refer to notes as requested by council C 06-10-17 DRAFT ISSUE- for consultants review
A 20-01-17 DRAFT ISSUE- for consultants review
ISSUE DATE AMENDMENT



RESIDENTIAL DEVELOPMENT	١.
SITE ADDRESS:	
59 CUDGEGONG ROAD, ROUSE HILL, NSW	
2155	
CLIENT: The Wickwood Property Group Pty Ltd	
The Wickwood Froperty Group Fty Eta	1

	SHEET TITLE:				
ELEVATIONS					
٧					
	DESIGN: NS	DRAWN: AJRSA	DATE: JUNE 2016	SC/ AS	

DA-A300